



## ADDENDUM

Public Building Commission of Chicago | Richard J. Daley Center | 50 West Washington Street, Room 200 | Chicago, Illinois 60602 | (312) 744-3090 | pbcchicago.com

**ADDENDUM NO.:** 06  
**PROJECT NAME:** Sauganash Elementary School Annex II and Renovations  
**PROJECT NO.:** 05425  
**CONTRACT NO.:** C1601  
**DATE OF ISSUE:** November 8, 2021

### NOTICE OF CHANGES, MODIFICATIONS, OR CLARIFICATIONS TO CONTRACT DOCUMENTS

The following changes, modifications, or clarifications are hereby incorporated and made an integral part of the Contract Documents. Unless clearly expressed otherwise by this Addendum, all terms and conditions defined in the original Contract Documents shall continue in full force and effect and shall have the same meaning in this Addendum. Issued Addenda represent responses/clarifications to various inquiries. Contractors shall be responsible for including all associated labor/material costs in its bid. Drawings/specifications corresponding to inquiry responses will be issued with the Issue for Construction Documents, upon issuance of building permit.

**ITEM NO. 1: CHANGE TO KEY DATES**

- Change 1** The **Bid Due Date and Time** has been **RESCHEDULED** to Wednesday, November 10, 2021 at 11:00a.m.  
**Change 2** The **Pre-Award Meeting Date and Time** has been **RESCHEDULED** to Tuesday, November 16, 2021 at 9:30a.m.

**ITEM NO. 2: REVISIONS TO BOOK 1 – PBC INSTRUCTIONS TO BIDDERS**  
None.

**ITEM NO. 3: REVISIONS TO BOOK 2 – PBC STANDARD TERMS AND CONDITIONS**  
None.

**ITEM NO. 4: REVISIONS TO BOOK 3 – TECHNICAL SPECIFICATIONS**  
None.

**ITEM NO. 5: REVISIONS TO DRAWINGS**

- Change 1** **REVISED** Drawing No. G-002, Schedule of Drawings & Project Information:  
a. Revised drawing index.  
**Change 2** **ADDED** Drawing No. ERS0, Notes.  
**Change 3** **REVISED** Drawing No. ERS1, Earth Retention System.  
a. ERS location slighting revised in plan.

**ITEM NO. 6: REQUESTS FOR INFORMATION**  
None.

This Addendum includes the following attached Specifications and/or Documents:


None

This Addendum includes the following attached Drawings:

1. G-002, Schedule of Drawings & Project Information, dated 11/08/21.
2. ERS0, Notes, dated 11/08/21.
3. ERS1, Earth Retention System, dated 11/08/21.

**END OF ADDENDUM NO. 06**




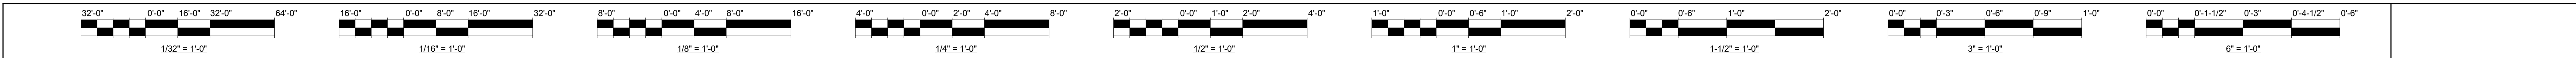


ABBREVIATIONS	
ABB	DESCRIPTION
AC	AIR CONDITIONING
ABV	ABOVE
AC	ARCHITECTURAL CONCRETE
ACM	ALUMINUM COMPOSITE MATERIAL
ACT	ACOUSTIC CEILING TILE
AD	AREA DRAIN
ADA	AMERICANS WITH DISABILITIES ACT
ADJ	ADJACENT
ADO	AUTOMATIC DOOR OPENER
ADOP	AUTOMATIC DOOR OPENER ON PEDESTAL
AEG	ARCHITECTURALLY EXPOSED CONCRETE
AEED	AUTOMATED EXTERNAL DEFRIGERATOR
AESS	ARCHITECTURALLY EXPOSED STRUCTURAL STEEL
AFF	ABOVE FINISHED FLOOR
AHV	AIR HANDLING UNIT
AB	AIR INFILTRATION BARRIER
ALT	ALTERNATE
ALUM/AL	ALUMINUM
ANOD	ANODIZED
AGR	AREA OF REFUGE
AP	ACCESS PANEL
APPROX	APPROXIMATE
ARA	AREA OF RESCUE ASSISTANCE
ARCH	ARCHITECTURAL
ASH	ACOUSTICAL SEALANT
ASH	ADJUSTABLE SHOWER HEAD
AWP	ACOUSTIC WALL PANEL
B	BASE CABINET
BT	BOTTOM OF
BBV	BID-BASED TIE
BD	BOARD
BF	BOTTLE FILLER
BLD	BUILDING
BLK	BLOCKING
BEAL	BEHIND
BO	BY OWNER
BRZ	BRONZE
BS	BOTH SIDES
BSMT	BASEMENT
CAB	CABINET
CB	CATCH BASIN
CD	CORNICE DRAIN
CH	CORNER GUARD
CH	COAT HOOK
CH	CAST IRON
CJ	CONTROL JOINT
CL	CENTER LINE
CLO	CEILING
CLG	CLOSET
CLR	CLEARANCE
CMU	CONCRETE MASONRY UNIT
CNTR	COUNTER
CO	CLEAN OUT
COL	COLUMN
CONC	CONCRETE
CONSTR	CONSTRUCTION
CONT	CONTINUOUS
CONTR	CONTRACTOR
CORR	CORROD
CP	CENTER POINT
CPT	CARPET (BROADLOOM)
CPTT	CARPET TILE
CR	CARD READER
CT	CERAMIC TILE
CTB	CERAMIC TILE BASE
CTF	CERAMIC TILE FLOOR
CTR	CENTER
CTW	CERAMIC TILE WALL
CW	COLD WATER
D	DATA OUTLET
DBL	DOUBLE
DF	DRINKING FOUNTAIN
DI	DIAMETER
DIA	DIAGONAL
DM	DIMENSION
DISH	DISHWASHER
DO	DAYLITE OPENING
DN	DOWN
DR	DOOR
DT	DOWNSPOUT
DTL	DETAIL
DW	DOMESTIC WATER
DWG	DRAWINGS
DWR	DRAWER
EA	EACH
EC	EXPOSED CONSTRUCTION
EFC	EACH FACE
EH	EXHAUST HOOD
EHD	ELECTRIC HAIR DRYER
EL	EXPANSION JOINT
EL ELEV	ELEVATION
ELEC	ELECTRICAL
EMS	ENTRANCE MAT SYSTEMS
ENCL	ENCLOSURE
EQ	ELECTRICAL PANEL
EQU	EQUAL
EQUIP	EQUIPMENT
EWC	ELECTRIC WATER COOLER
EWS	EYE WASH STATION
EXIST	EXISTING
EXP	EXPOSED
EXP	EXISTING TO REMAIN
EXT	EXTERIOR
F	FLUSH DOOR
F	FACE OF
FAFP	FIRE ALARM SYSTEM ANNUNCIATOR PANEL
FAB	FABRIC
FACP	FIRE ALARM CONTROL PANEL
FAP-X	FIRE WRAPPED ACOUSTIC PANEL - (X = THICKNESS OF THE PANEL)
FB	FACE BRICK
FBN	FLIP BENCH
FBO	FURNISHED BY OWNER
FCD	FLOOR CLEAN OUT
FD	FLOOR DRAIN
FDN	FOUNDATION
FE	FIRE EXTINGUISHER
FEBC	FIRE EXTINGUISHER CABINET
FECB	FIRE EXTINGUISHER CABINET AND BLANKET
FF	FACTORY FINISH

ABBREVIATIONS	
ABB	DESCRIPTION
FG	FULL GLASS DOOR
FGH	FULL GLASS DOOR - PAIR
FIN	FINISH
FL	FLUSH LOUVER DOOR
FL-2	FLUSH LOUVER DOOR - PAIR
C-DOOR	PORCELAIN TILE STAIR TREAD
FOF	FACE OF FOUNDATION
FOM	FACE OF MASONRY
FOS	FACE OF STUD
FW	FACE OF WALL
FT	FOOT / FEET
FTG	FOOTING
GA	GAUGE
GALV	GALVANIZED
GAS	GAS METER AND REGULATOR
GB	GRAB BAR
GC	GENERAL CONTRACTOR
GL	GLASS
GL BLK	GLASS BLOCK
GL-2	GLAZING
GRND	GROUND
GSM	GALVANIZED SHEET METAL
GWB	GYPSUM WALL BOARD
GYP	GYPSUM
HB	HUGE BOBB
HC	HANDICAPPED
HD	ELECTRIC HAND DRYER
HDS	HIGH DENSITY STORAGE
HDWR	HARDWARE
HG	HALF GLASS DOOR
HG-2	HALF GLASS DOOR PAIR
HM	HOLLOW METAL
HORIZ	HORIZONTAL
HP	HIGH POINT
HPC	HIGH PERFORMANCE COATING
HR	HOUR
HT	HEIGHT
HVAC	HEATING, VENTILATION, AIR CONDITIONING
HW	HOT WATER
HHW	HOT WATER HEATER
ID	INSIDE DIAMETER
IN	INCH
INFO	INFORMATION
INSUL	INSULATION
INT	INTERIOR
INT	INTERIOR PART SYSTEM
JC	JANITOR'S CLOSET
JT	JOINT
KB	KNOX BOX
KS	KNEE SPACE
L	LAUNDRY
LAV	LAVATORY
LIN	LINOLEUM
LP	LOW POINT
LTL	LINTEL
CONSTR	CONSTRUCTION
LVT	LUXURY VINYL TILE
M	MIRROR
MATL	MATERIAL
MAX	MAXIMUM
NBR	MARKING BOARD (DENOTES WIDTH REFERRING TO INTERIOR ELEVATIONS FOR MOUNTING HEIGHTS)
MCOM	METAL COMPOSITION MATERIAL
MD	MASONRY DIMENSION
MEF	MEDIUM DENSITY FIBERBOARD
MECH	MECHANICAL
MED	MEDIUM
MEZZ	MEZZANINE
MFR	MANUFACTURER
MH	MANHOLE
MIN	MINIMUM
MISC	MISCELLANEOUS
ML	MATCH LINE
NO	MASONRY OPENING
NP	METAL PANEL
NST	MOSAIC TILE
NSTB	MOSAIC TILE BASE
NT	METAL TRANSITION
NMT	MOUNTED
NTL	METAL
MU	MECHANICAL UNIT
MULL	MULLION
MWR	MICROWAVE
MLW	MLLWORK
MWL	METAL WARDROBE LOCKER
MX	MAILBOX UNIT
NC	NOISE CRITERIA
NC	NOT IN CONTRACT
NL	NARROW LIGHT DOOR
NLR	NARROW LIGHT DOOR - RATED
NLR-2	NARROW LIGHT DOOR - RATED PAIR
NO	NUMBER
NOM	NOMINAL
NR	NO REQUIREMENT
NTS	NOT TO SCALE
OA	OVERALL
OC	ON CENTER
OC	OVERHEAD COILING DOOR
OD	OUTSIDE DIAMETER
OH	OPPOSITE HAND
OPNG	OPENING
OPP	OPPOSITE
ORD	OVERFLOW ROOF DRAIN
OSB	ORIENTED STRAND BOARD
OSD	OPEN SITE DRAIN
P	PHONE OUTLET
PART	PARTITION
PATT	PATTERN
PC	PRECAST CONCRETE
PCO	POLISHED CONCRETE
PL	PROPERTY LINE
PLAM	PLASTIC LAMINATE
PLWD	PLYWOOD
PNT	PAINT
PR	PAIR
PREFAB	PREFABRICATED
PSE	MOTORIZED PROJECTION SCREEN
PSF	POUNDS PER SQUARE FOOT
PSI	POUNDS PER SQUARE INCH

ABBREVIATIONS	
ABB	DESCRIPTION
PSM	MANUAL PROJECTION SCREEN
PT	PORCELAIN TILE
PTB	PORCELAIN TILE BASE
PTD	PAPER TOWEL DISPENSER
PTD	PAINTED
PTF	PORCELAIN TILE FLOOR
PTF	PORCELAIN TILE STAIR TREAD
PTWS	PORCELAIN TILE/TACTILE WARNING STRIP
PTW	PORCELAIN TILE WALL
PVC	POLYVINYL CHLORIDE
Q	QUAD POWER OUTLET
QT	QUARRY TILE
QTY	QUANTITY
R	RISER
RAD	RADIUS
RAL	RUBBER LADDER
RB	RESILIENT BASE
RBST	RUBBER STAIR TREAD
RD	ROOF DRAIN
REF	REFERENCE / REFER TO
REF	REFRIGERATOR
REF	REINFORCED
REQD	REQUIRED
RES	RESINOUS FLOORING
RESB	RESINOUS INSULATED BASE
REV	REVISION
RFL	RUBBER FLOOR
RFT	RUBBER FLOOR TILE
RM	ROOM
RO	ROUGH OPENING
ROW	RIGHT OF WAY
RSN	RESIN PANEL
RSE	ROLLER SHADE - MOTORIZED
RSES	SKYLIGHT ROLLER SHADE - MOTORIZED
RSL	ROLLER SHADE LEFT CONTROL
RSR	ROLLER SHADE RIGHT CONTROL
RSB	RESILIENT STAIR TREAD
RT	RESILIENT TRANSITION
RTF	RESILIENT TILE FLOOR
RTU	ROOF TOP UNIT
RUBR	RUBBER
S	SOLID CORE
SCHED	SCHEDULE
SCWD	SOLID CORE WOOD
SD	SOAP DISPENSER
SECT	SECTION
SHT	SHEET
SIM	SIMILAR
SND	SANITARY NAPKIN DISPOSAL
SNV	SANITARY NAPKIN VENDOR
SPEC	SPECIFICATION
SMI	SINGLE PLY MEMBRANE
SQL	SQUARE
SS	STAINLESS STEEL
SSF	SOLID SURFACE
SSG	SILICONE STRUCTURAL GLAZING
SEALANT	SEALANT
ST	STEEL
STC	SOUND TRANSMISSION COEFFICIENT
STD	STANDARD
STL	STEEL
STOR	STORAGE
STRUCT	STRUCTURAL
STT	STONE THRESHOLD
STV	STOVE
SUSP	SUSPENDED
SHT	SHEET
SYM	SYMMETRICAL
T	TREAD
TI	TOP OF
TF	TACKBOARD (IF DENOTES WIDTH; REFER TO INTERIOR ELEVATIONS FOR MOUNTING HEIGHTS)
TBR	TOWEL BAR
TC	TOWEL COMPARTMENT
TREN	TRENCH DRAIN
TEL	TELEPHONE
TF	TOP OF FINISH FLOOR
THK	THICK
TP	TOWEL PAPER
TPT	TOWEL PAPER DISPENSER
TPO	THERMOPLASTIC OLFIN
TRZ	TERRAZZO
TSF	TACK STRIP (IF DENOTES WIDTH; REFER TO INTERIOR ELEVATIONS FOR MOUNTING HEIGHTS)
TV	TELEVISION
TYP	TYPICAL
UC	UNDER COUNTER
UNO	UNLESS NOTED OTHERWISE
UR	URNAL
US	URNAL SCREEN
VB	VAPOR BARRIER
VBS	NEGRESSED VULCANIZ FLOOR SLEEVE
VC	VOLUME CONTROL
VCT	VINYL COMPOSITION TILE
VDB	VINYL DISPLAY BOARD
VEND	VENDING MACHINE
VERT	VERTICAL
VEST	VESTIBULE
VF	VERIFY IN FIELD
VP	VENT PIPE
VNT	VINYL TILE
VWC	VINYL WALL COVERING
W	WALL CABINET
WI	WITH
WD	WASHER / DRYER
WO	WITHOUT
WC	WATER CLOSET
WCO	WALL CLEAN OUT
WD	WOOD
WF	WOOD FINISH
WM	WALKOFF MAT
WP	WATERPROOF
WPL	WOOD PANEL
WPT	WORK POINT
WR	WATER RESISTANT
WWF	WELDED WIRE FABRIC
YCO	YARD CLEAN OUT

- ### GENERAL NOTES
- ALL WORK SHALL BE COMPLIANT WITH THE CODES, ORDINANCES, AND REGULATIONS OF THE AUTHORITIES HAVING JURISDICTION OVER THE PROJECT LOCATION.
  - THE TRADE CONTRACTOR'S PERSONNEL SHALL NOT BE ALLOWED ON THE PROJECT SITE WITHOUT COMPLYING WITH THE OWNER'S SECURITY PROTOCOLS.
  - WHERE CONFLICTS EXIST WITHIN OR BETWEEN PARTS OF THE CONTRACT DOCUMENTS, OR BETWEEN THE CONTRACT DOCUMENTS AND APPLICABLE STANDARDS, CODES, ORDINANCES, AND REGULATIONS THE MORE STRINGENT OR HIGH QUALITY OR GREATER QUALITY REQUIREMENT(S) SHALL APPLY. LARGE SCALE DRAWINGS TAKE PRECEDENCE OVER SMALL-SCALE DRAWINGS. FIGURED DIMENSIONS TAKE PRECEDENCE OVER SCALE DIMENSIONS, AND NOTED MATERIALS TAKE PRECEDENCE OVER GRAPHIC REPRESENTATIONS.
  - THE CONTRACT DOCUMENTS IDENTIFY THE MINIMUM AMOUNT OF WORK REQUIRED. TRADE CONTRACTORS SHALL PROVIDE THE EXTENT OF WORK NECESSARY FOR A COMPLETE INSTALLATION.
  - REFER TO THE PROJECT MANUAL FOR PRODUCTS, MATERIALS, AND PROCEDURES NOT IDENTIFIED ON THE CONTRACT DRAWINGS.
  - THE ACTUAL AREA(S) OF WORK SHALL BE KEPT TO THE MINIMUM REQUIRED TO PROPERLY EXECUTE THE CONTRACT REQUIREMENTS. EXISTING DIMENSIONS AND HATCHED AREAS INDICATED ON CONTRACT DOCUMENTS ARE FOR GENERAL REFERENCE AND BIDDING PURPOSES ONLY.
  - TO BID BIDDING, THE TRADE CONTRACTORS SHALL FIELD VERIFY THE EXTENT OF WORK REQUIRED TO PROPERLY EXECUTE THE CONTRACT REQUIREMENTS. ADDITIONAL WORK THAT IS REQUIRED, WAS VISIBLE, AND COULD HAVE BEEN IDENTIFIED DURING BIDDING SHALL BE COMPLETED BY THE RESPONSIBLE TRADE CONTRACTOR(S) AT NO ADDITIONAL COST TO THE OWNER.
  - THE TRADE CONTRACTORS SHALL BE FAMILIAR WITH THE EXISTING CONDITIONS AND NOTIFY THE ARCHITECT OR CONSTRUCTION MANAGER OF ANY CONFLICTS WITH THE CONSTRUCTION DOCUMENTS PRIOR TO PREPARING SUBMITTALS OR BEGINNING ANY WORK.
  - THE TRADE CONTRACTORS SHALL PROVIDE ALL TEMPORARY CONSTRUCTION AND SHORING REQUIRED TO PROPERLY EXECUTE THE CONTRACT REQUIREMENTS OF THE CONTRACT.
  - ALL EXTERIOR OPENINGS SHALL BE SECURED AT ALL TIMES WHEN WORK IS NOT BEING PERFORMED. THE TRADE CONTRACTORS SHALL NOT REMOVE EXISTING DOORS, FRAMES, WINDOWS, ETC. UNTIL REPLACEMENTS ARE ONSITE AND READY FOR INSTALLATION. IF INSTALLATION OF DOORS, FRAMES, WINDOWS, ETC. CANNOT BE COMPLETED BY THE END OF THE WORK DAY, THE RESPONSIBLE TRADE CONTRACTORS SHALL PROVIDE TEMPORARY WEATHERPROOF CONSTRUCTION AS REQUIRED TO SECURE THE BUILDING TO THE SATISFACTION OF THE OWNER AND RESTORE AFFECTED SURFACES TO THEIR ORIGINAL CONDITION.
  - PATCHING, REPAIRING, AND REFINISHING WORK SHALL BE PERFORMED BY THOSE REGULARLY INVOLVED IN THAT TRADE AND SHALL MATCH THE EXISTING ADJACENT CONSTRUCTION AS CLOSELY AS POSSIBLE IN MATERIAL, FINISH, COLOR, TEXTURE AND SHEEN. REFER TO THE CONTRACT DRAWINGS FOR EXISTING BUILDING CONSTRUCTION TO REMAIN.
  - TRADE CONTRACTORS SHALL PROTECT THEIR WORK AND EXISTING CONSTRUCTION, FINISHES, AND EQUIPMENT TO REMAIN TO PREVENT DAMAGE. ANY WORK AND/OR EXISTING FINISHES TO REMAIN DAMAGED DURING THE REMOVAL OF EXISTING WORK OR THE INSTALLATION OF NEW WORK SHALL BE REPAIRED, REPLACED, AND REFINISHED BY THE RESPONSIBLE TRADE CONTRACTOR TO MATCH THE ORIGINAL CONDITION AT NO ADDITIONAL COST TO THE OWNER AND TO THE SATISFACTION OF THE OWNER AND ARCHITECT.
  - THE ARCHITECT SHALL REVIEW AND APPROVE LOCATIONS FOR ALL JUNCTION BOXES AND RACEWAYS PRIOR TO INSTALLATION OF WIRING / CABLEING.
  - EXISTING SITE FEATURES, MATERIALS, AMENITIES, LANDSCAPING, ETC. DAMAGED BY CONSTRUCTION OPERATIONS AND NOT SCHEDULED FOR DEMOLITION SHALL NOT BE REMOVED OR DESTROYED. EXISTING SHALL BE PAINTED. DO NOT PAINT MOVING PARTS OR LABELS. RESPONSIBLE TRADE CONTRACTOR(S) AT NO ADDITIONAL COST TO THE OWNER AND TO THE SATISFACTION OF THE OWNER AND ARCHITECT.
  - CONTRACTOR SHALL COORDINATE THE WORK WITH ALL PARTIES INVOLVED SO THAT THE CONSTRUCTION CAN PROCEED SMOOTHLY, WITHOUT TRADE INTERFERENCE OR WASTE OF TIME AND MATERIAL.
  - ALL PIPE & CONDUIT PENETRATIONS THROUGH FIRE RATED CONSTRUCTION SHALL BE FIRE STOPPED.
  - ALL FIRE ALARMS SHALL BE IN COMPLIANCE WITH NFPA72 AND CBC307.
  - WARNING: ASBESTOS-CONTAINING BUILDING MATERIALS ARE OR MAY BE PRESENT IN THIS BUILDING. AN ASBESTOS MANAGEMENT PLAN IS AVAILABLE IN THE SCHOOL FOR REVIEW UPON REQUEST. NO PERSON MAY DISTURB ASBESTOS-CONTAINING MATERIALS UNLESS THAT PERSON IS A LICENSED ASBESTOS WORKER OR CONDUCTS SUCH WORK IN ACCORDANCE WITH SPECIFICATION(S) CONTAINED IN THE PROJECT DOCUMENTS AND IN COMPLIANCE WITH ILLINOIS DEPARTMENT OF HEALTH RULES AND REGULATIONS.**

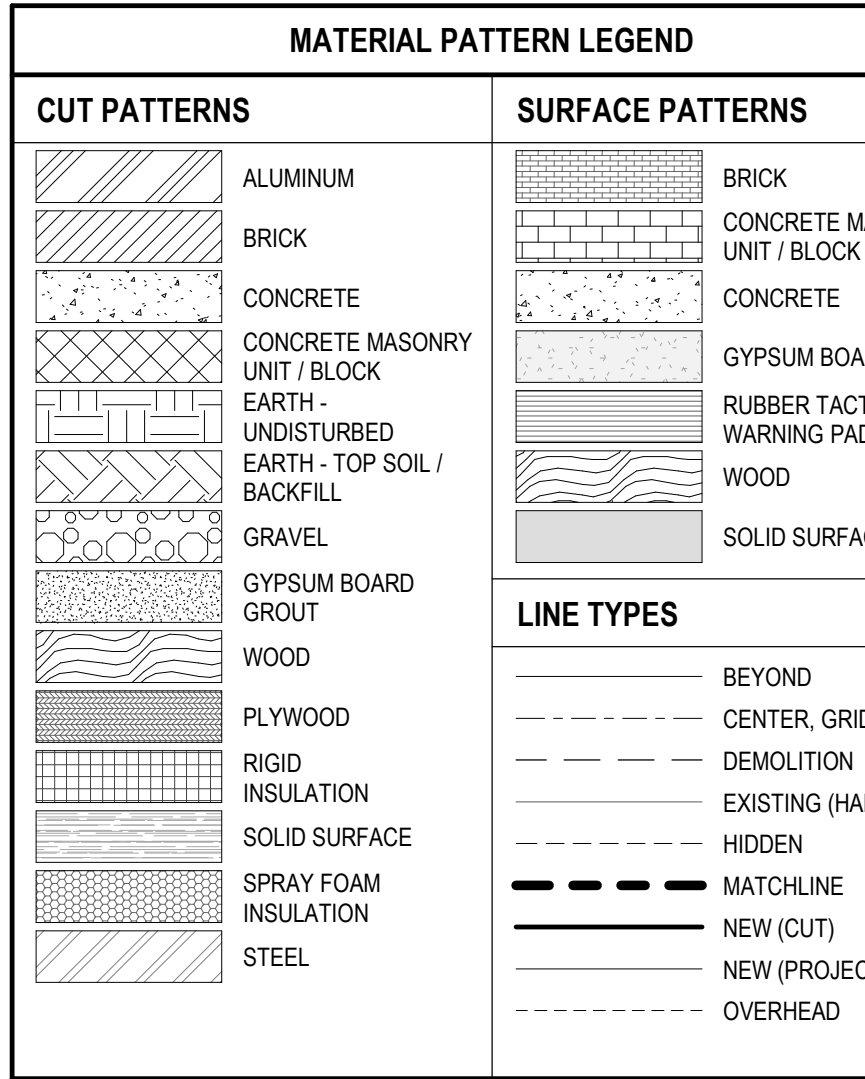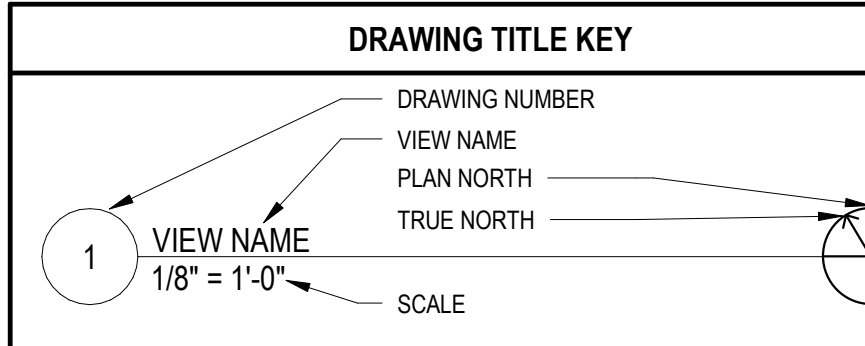

- ### GENERAL CONSTRUCTION / RENOVATION NOTES
- AFTER REMOVAL OF ITEMS IDENTIFIED TO BE REMOVED, CLEAN AND REPAIR THE EXISTING SURFACES TO REMAIN TO MATCH THE CONSTRUCTION MATERIALS AND METHODS, FINISHES, TEXTURE, PATTERN, COLOR AND SHEEN OF THE ADJACENT SURFACES TO REMAIN. PATCH, CLEAN, PREPARE, PAINT, ETC. EXISTING SURFACES AS REQUIRED.
  - WHERE EXISTING EQUIPMENT IS REMOVED AND NEW EQUIPMENT IS SMALLER AND INSTALLED IN THE SAME LOCATION, CLEAN AND REPAIR THE SIGHT-EXPOSED SURFACES TO REMAIN TO MATCH THE CONSTRUCTION MATERIALS AND METHODS, FINISHES, TEXTURE, PATTERN, AND COLOR OF THE ADJACENT SURFACES TO REMAIN. PATCH, CLEAN, PREPARE, PAINT, ETC. EXISTING SURFACES AS REQUIRED.
  - EXISTING AND NEW FIRE RATED ASSEMBLIES ARE TO BE MAINTAINED AND BE IN CONFORMANCE WITH APPLICABLE CODES. PENETRATIONS SHALL BE CONSTRUCTED AND SEALED AS REQUIRED. NEW FIRE RATED ASSEMBLIES SHALL BE INSPECTED, CERTIFIED, AND APPROPRIATELY LABELED ABOVE CEILING.
  - ALL PENETRATIONS THROUGH ANY MATERIAL SHALL BE SEALED WITH A COMPARABLE MATERIAL, APPROVED BY THE ARCHITECT PRIOR TO INSTALLATION.
  - MASONRY INFILL AND/OR PATCHING SHALL MATCH THE MATERIAL, SIZE, FINISH, COLOR, TEXTURE AND COURSEWORK OF EXISTING MASONRY TO REMAIN. NEW MASONRY SHALL BE WHOLE UNITS TOOTHED INTO THE EXISTING MASONRY. NO SAW CUT EDGES WILL BE ALLOWED. MORTAR JOINTS TO MATCH COLOR, TEXTURE AND PROFILE OF ADJACENT MASONRY.
  - STRUCTURAL LINTELS ARE REQUIRED AT ALL OPENINGS AND RECESSES IN LOAD BEARING AND NON-LOAD BEARING MASONRY WALLS. REFER TO STRUCTURAL DRAWINGS.
  - EXPOSED OUTSIDE CORNERS OF INTERIOR CONCRETE MASONRY UNITS SHALL BE ROUNDED, UNO.
  - PROVIDE A CONTINUOUS BEAD OF SEALANT BETWEEN DISSIMILAR MATERIALS, UNO.
  - PROVIDE GALVANIC PROTECTION SEPARATING DISSIMILAR METALS.
  - ALL EXPOSED PIPING AND CONDUIT SHALL BE KEPT AS CLOSE AS POSSIBLE TO WALLS, STRUCTURE, AND FLOOR/ROOF DECK.
  - ALL WALLS ABOVE DOORS/FRAMES TO EXTEND TO UNDERSIDE OF DECK, UNO.
  - ALL EXTERIOR DIMENSIONS ARE TO THE OUTSIDE FACE OF FINISH MATERIAL, UNO.
  - SLOPE ALL CONCRETE AND/OR TOPPING TO FLOOR DRAINS; COORDINATE WITH PLUMBING DRAWINGS.
  - CENTER SPRINKLER HEADS AND LIGHT FIXTURES, SECURITY DEVICES, WAPS, EXIT SIGNS, & SIMILAR DEVICES IN ACT LINES, UNO.
  - INSTALL WOOD BLOCKING AS NEEDED FOR ALL WALL MOUNTED ITEMS.

- ### GENERAL FINISH NOTES
- ALL NEW CONSTRUCTION AND IDENTIFIED EXISTING CONSTRUCTION TO REMAIN SHALL BE PRIME AND FINISH PAINTED UNLESS MATERIALS ARE PRE-FINISHED. REFER TO THE FINISH PLANS AND THE PROJECT MANUAL FOR ADDITIONAL INFORMATION. NEW PARTITIONS AND SOFFITS ARE TO BE PRIME PAINTED FOR FULL HEIGHT OF PARTITION OR SOFFIT. SIGHT-EXPOSED SURFACES OF NEW PARTITIONS AND SOFFITS ARE TO BE FINISH PAINTED.
  - ALL WALLS IN EXISTING ROOMS IN WHICH WORK IS OCCURRING:
    - REPAIR HOLES, DEFECTS, ETC. IN EXISTING PLASTER AND CONCRETE BLOCK UNPAINTED.
    - AT REPAIRS AND UNPAINTED CONCRETE BLOCK PROVIDE BLOCK FILL PAINT AND TWO FINISH COATS OF PAINT, AND
    - PAINTS ONE FINISH COAT OF PAINT OVER EXISTING PAINTED
  - IN REGULARLY OCCUPIED SPACES IN AREAS OF RENOVATION, ALL SIGHT-EXPOSED MEPF COMPONENTS INCLUDING, BUT NOT LIMITED TO, DUCTWORK, PIPING, FITTINGS, CONDUIT, BOXES, HANGERS, ETC. SHALL BE PAINTED. DO NOT PAINT MOVING PARTS OR LABELS.
  - DO NOT PAINT EXISTING FACE BRICK, GROUND FACE CMU OR SOFT, UNO.

## SCHEDULE OF DRAWINGS





- ### GENERAL DRAWINGS:
- |       |  |
|-------|--|
| G-001 | COVER SHEET  |
| G-002 | SCHEDULE OF DRAWINGS & PROJECT INFO (REV IN ADDENDUM NO. 1, NO. 2, NO. 4, NO. 5) |
| G-001 | CODE & ZONING MATRIX (REVISED IN ADDENDUM NO. 1)                                 |
| G-102 | CODE INFORMATION & LIFE SAFETY REFERENCE PLANS                                   |
| G-103 | CODE INFORMATION & LIFE SAFETY REFERENCE PLANS (REV IN ADDENDUM NO. 2)           |
| G-104 | CODE INFORMATION & LIFE SAFETY REFERENCE PLANS                                   |
| G-105 | DOB & MOPD MEETING & MINUTES   |
| G-106 | APPROVED ACAS & INFORMATION  |
| G-107 | PHASING PLANS (REVISED IN ADDENDUM NO. 2 & NO. 4)                                |
| G-201 | SURVEY FOR REFERENCE   |
- ### ACCESSIBILITY - CPS STANDARDS
- |          |   |
|----------|---|
| ADA.01   | EXTERIOR SIGNAGE DETAILS (REVISED IN ADDENDUM NO. 1)                      |
| ADA.02   | INTERIOR SIGNAGE DETAILS (REVISED IN ADDENDUM NO. 1 & NO. 2)              |
| ADA.03   | PERMANENT ROOM IDENTIFICATION SIGNAGE DETAILS (REVISED IN ADDENDUM NO. 4) |
| ADA.10   | ACCESSIBLE MOUNTING HEIGHTS & SCHEDULE                                    |
| ADA.11   | ACCESSIBLE STALL AND URINAL LAYOUT  |
| ADA.12   | ACCESSIBLE STALL ELEVATIONS   |
| ADA.15   | DRINKING FOUNTAIN DETAILS   |
| ADA.16   | HYDRALIFT PASSENGER ELEVATOR DETAILS                                      |
| ADA.17.9 | TYPICAL ELEVATOR CONTROL DETAILS  |
| ADA.18.2 | VERTICAL PLATFORM LIFT DETAILS  |
| ADA.20   | ACCESSIBLE WINDOW FIRE EXTINGUISHER & ELEC. MOUNTING DETAIL               |

- ### ARCHITECTURAL DRAWINGS:
- |       |  |
|-------|--|
| AM100 | CONSTRUCTION MOCK UP   |
| AS100 | ARCHITECTURAL SITE DEMOLITION PLAN (REVISED IN ADDENDUM NO. 1 & NO. 4)           |
| AS101 | ARCHITECTURAL SITE PLAN (REVISED IN ADDENDUM NO. 1 & NO. 2)                      |
| AS102 | ARCHITECTURAL SITE PLAN (REVISED IN ADDENDUM NO. 2)                              |
| A100  | LOWER LEVEL DEMOLITION PLAN (REVISED IN ADDENDUM NO. 1)                          |
| A101  | FIRST FLOOR DEMOLITION PLAN & DETAILS (REVISED IN ADDENDUM NO. 2 & NO. 4)        |
| A102  | LOWER LEVEL DEMOLITION PLAN & DETAILS (REVISED IN ADDENDUM NO. 1)                |
| A103  | LOWER LEVEL DEMOLITION PLAN & DETAILS (REVISED IN ADDENDUM NO. 1, NO. 2 & NO. 4) |
| A104  | FIRST FLOOR DEMOLITION PLAN (REVISED IN ADDENDUM NO. 1, NO. 2 & NO. 4)           |
| A105  | SECOND FLOOR DEMOLITION PLAN (REVISED IN ADDENDUM NO. 1, NO. 2 & NO. 4)          |
| A106  | THIRD FLOOR DEMOLITION PLAN (REVISED IN ADDENDUM NO. 1, NO. 2 & NO. 4)           |
| A107  | EXISTING BUILDING ATTIC PLAN   |
| A108  | FIRST FLOOR SLAB EDGE PLAN (REVISED IN ADDENDUM NO. 1 & NO. 4)                   |
| A109  | SECOND FLOOR SLAB EDGE PLAN (REVISED IN ADDENDUM NO. 1 & NO. 4)                  |
| A110  | THIRD FLOOR SLAB EDGE PLAN (REVISED IN ADDENDUM NO. 1 & NO. 4)                   |
| A111  | FIREPROOFING PLANS (REVISED IN ADDENDUM NO. 1 & NO. 4)                           |
| A112  | ROOF PLANS - DEMOLITION & NEW WORK (REVISED IN ADDENDUM NO. 1, NO. 2, & NO. 4)   |
| A113  | ROOF DETAILS (REVISED IN ADDENDUM NO. 1)   |
| A114  | ROOF DETAILS (REVISED IN ADDENDUM NO. 1, NO. 2, & NO. 4)                         |
| A115  | ROOF PLANS - CHILLER   |
| A116  | ROOF PLANS - PLATFORM DETAILS  |
| A117  | LOWER LEVEL REFLECTED CEILING PLAN (REVISED IN ADDENDUM NO. 2 & NO. 4)           |
| A118  | FIRST FLOOR REFLECTED CEILING PLAN (REVISED IN ADDENDUM NO. 1, NO. 2 & NO. 4)    |
| A119  | SECOND FLOOR REFLECTED CEILING PLAN (REVISED IN ADDENDUM NO. 1, NO. 2 & NO. 4)   |
| A120  | THIRD FLOOR REFLECTED CEILING PLAN (REVISED IN ADDENDUM NO. 1, NO. 2 & NO. 4)    |
| A121  | ANNEX I EXTERIOR BUILDING ELEVATIONS (REVISED IN ADDENDUM NO. 1, NO. 2 & NO. 4)  |
| A122  | ANNEX II EXTERIOR BUILDING ELEVATIONS (REVISED IN ADDENDUM NO. 1, NO. 2 & NO. 4) |
| A123  | BUILDING SECTIONS  |
| A124  | BUILDING SECTIONS  |
| A125  | EXISTING BUILDING ELEVATIONS (REVISED IN ADDENDUM NO. 1, NO. 2, & NO. 4)         |
| A126  | MASONRY DETAILS SECTIONS (REVISED IN ADDENDUM NO. 1, NO. 2 & NO. 4)              |
| A127  | WINDOW DETAILS (REVISED IN ADDENDUM NO. 1, NO. 2 & NO. 4)                        |
| A128  | WALL SECTIONS (REVISED IN ADDENDUM NO. 1, NO. 2, & NO. 4)                        |
| A129  | WALL SECTIONS (REVISED IN ADDENDUM NO. 1, NO. 2, & NO. 4)                        |
| A130  | WALL SECTIONS (REVISED IN ADDENDUM NO. 1, NO. 2, & NO. 4)                        |





N HIAWATHA AVE

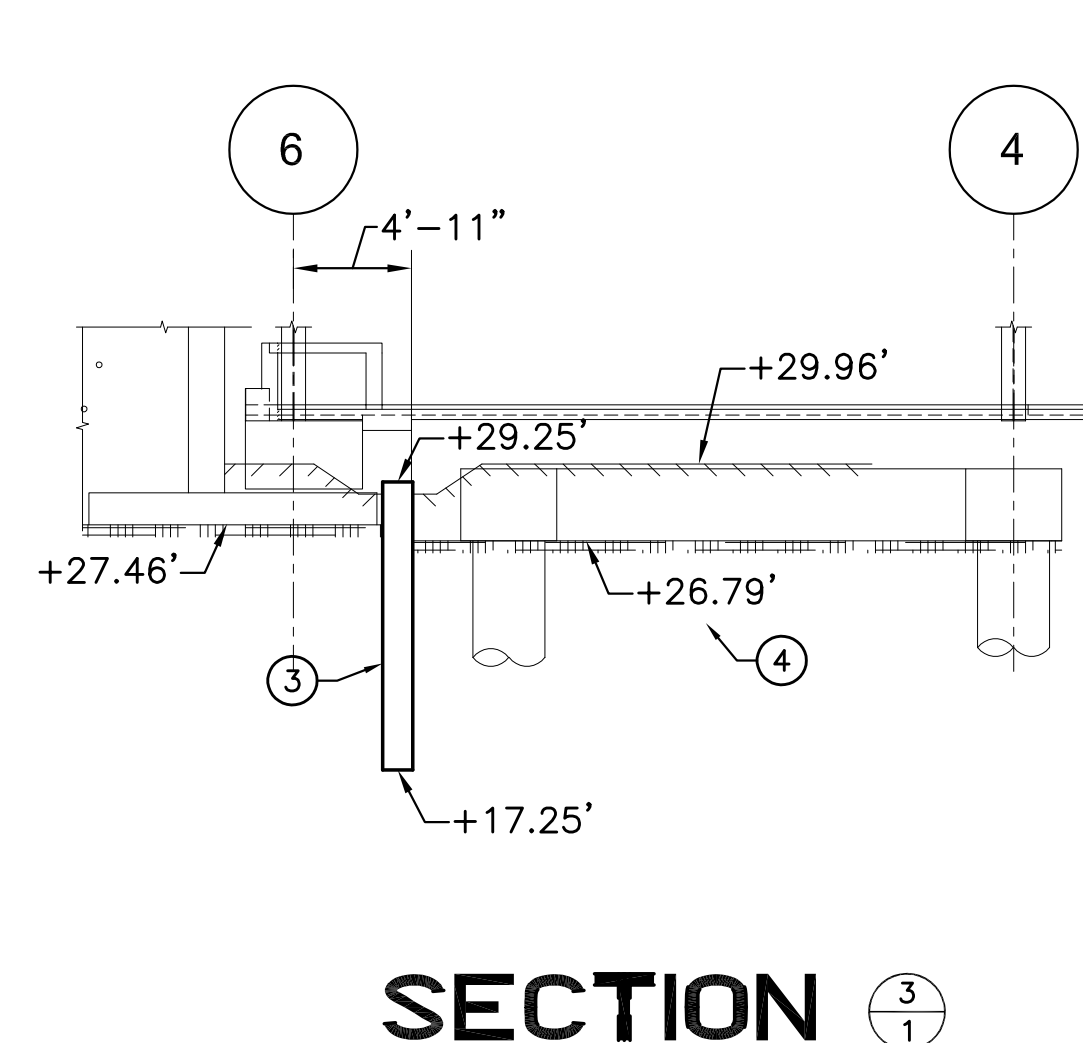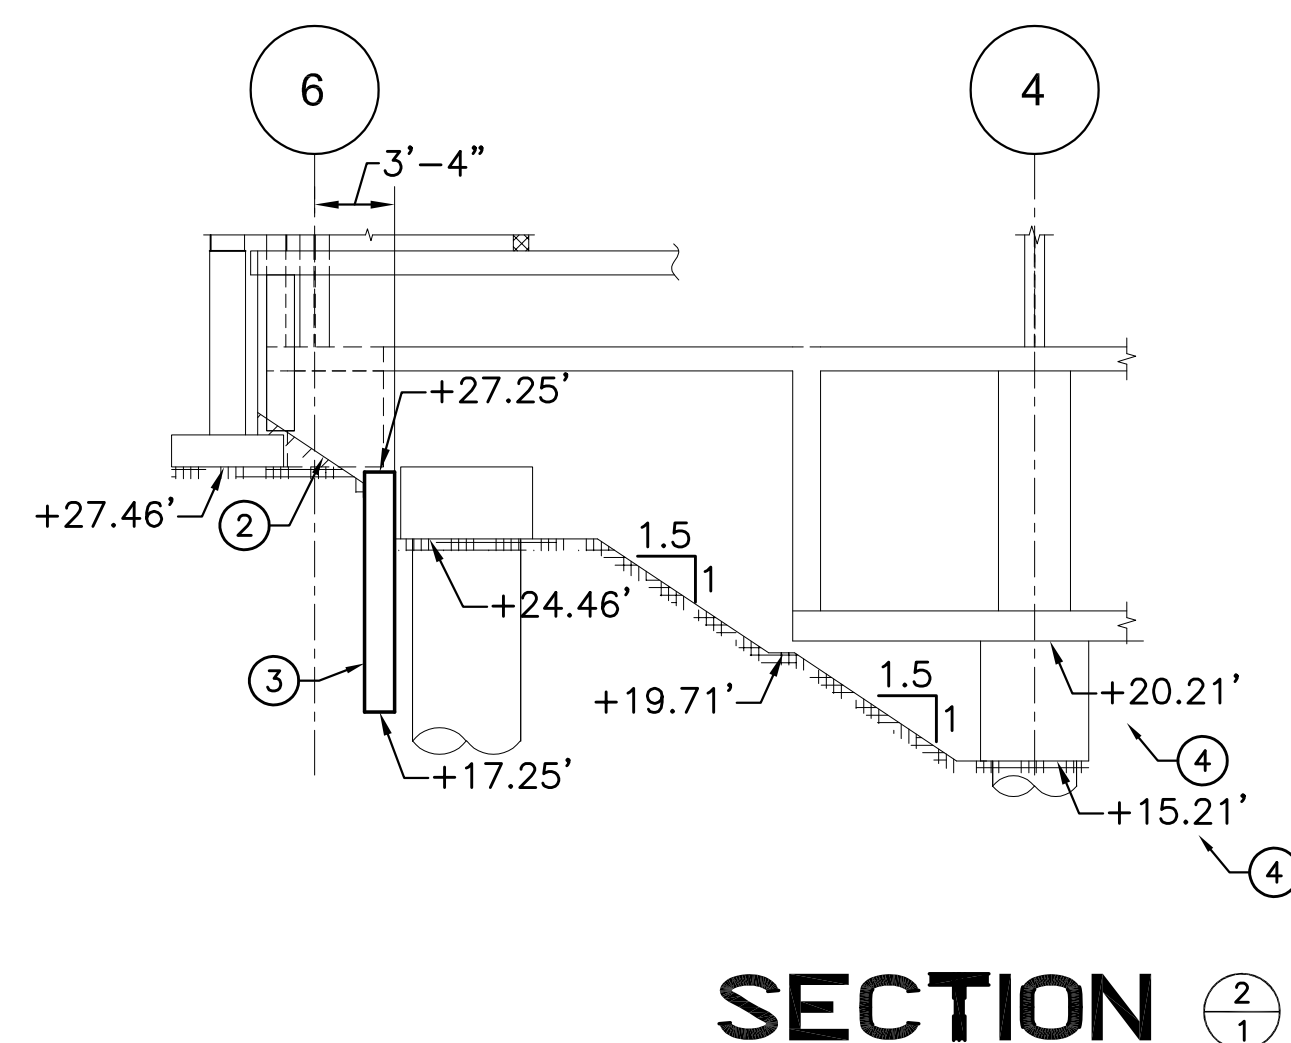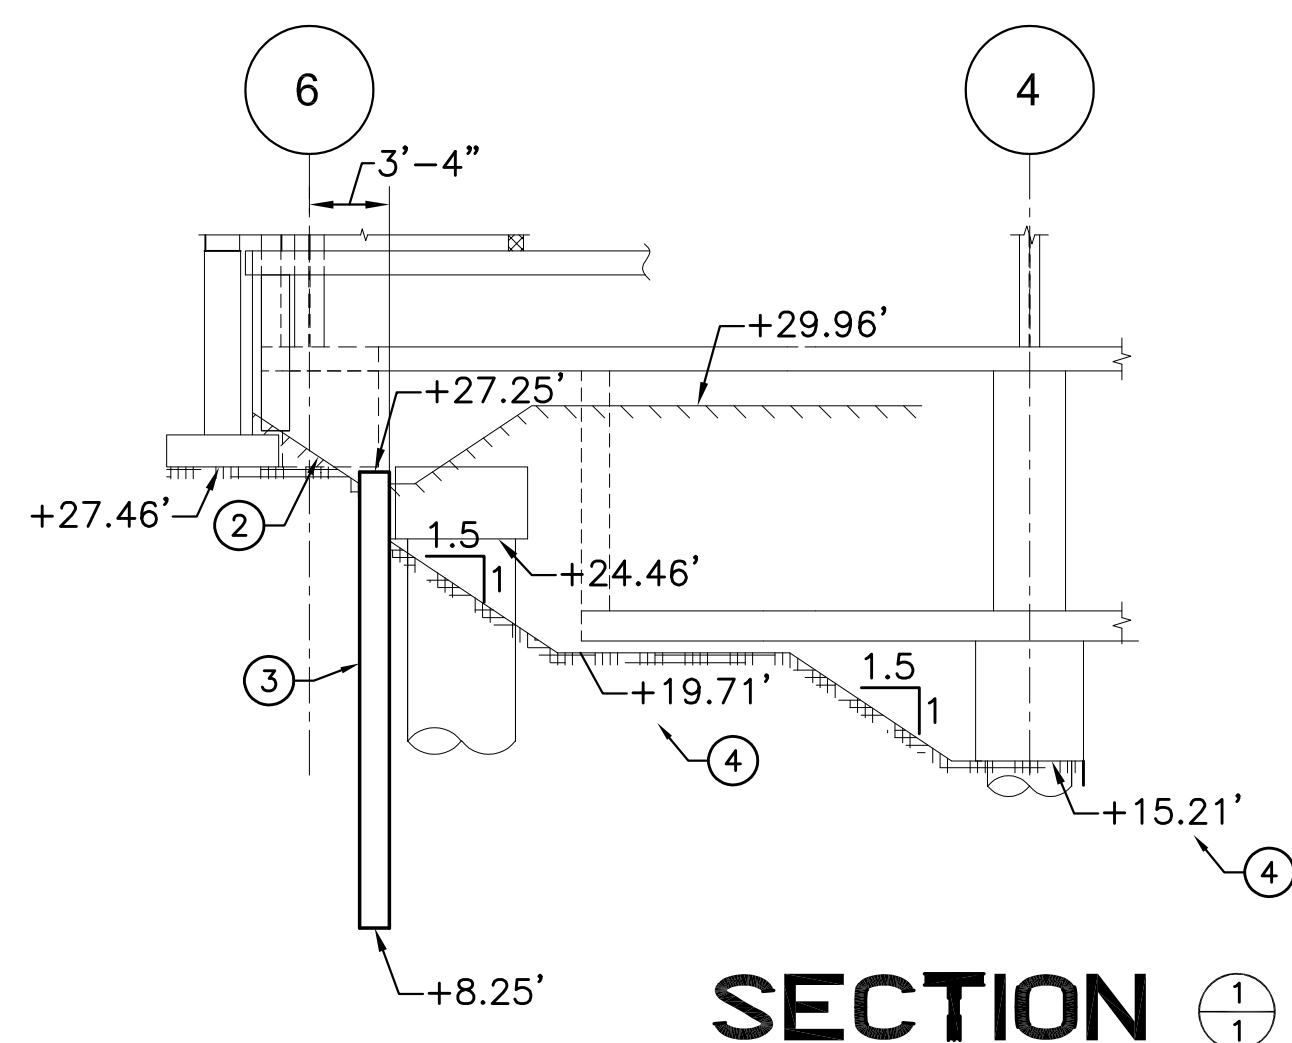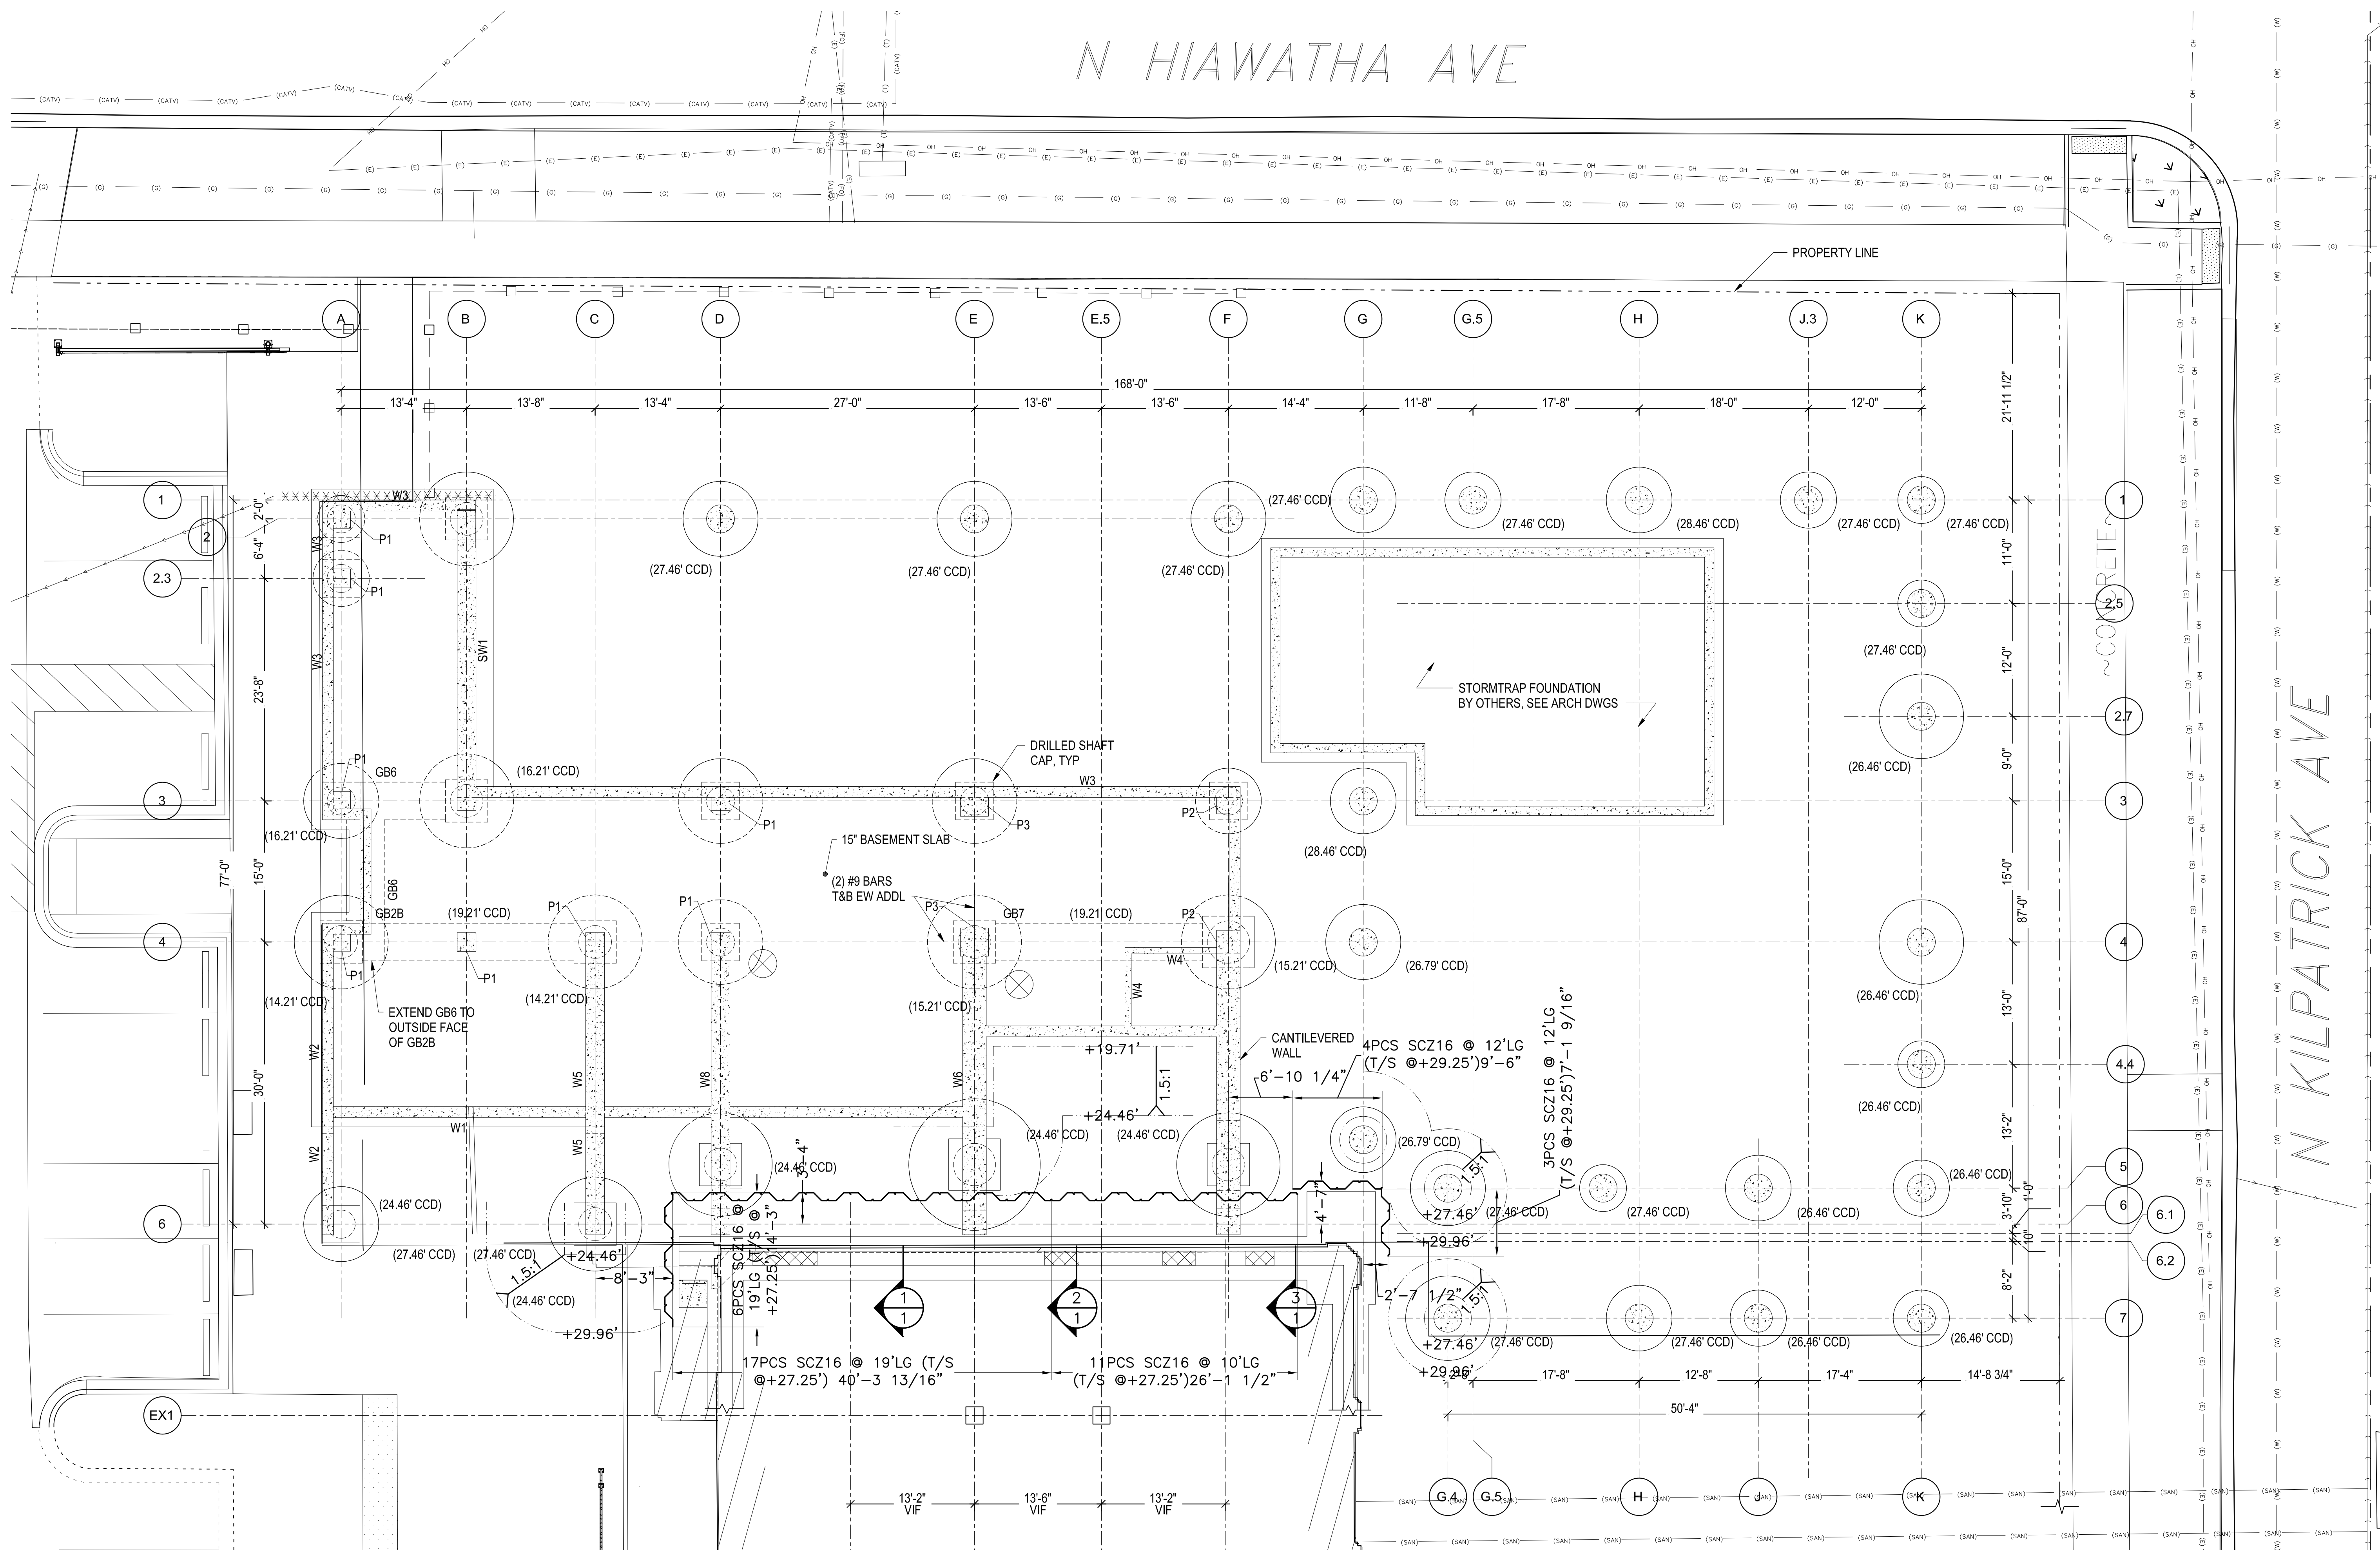

Construction Sequence


1. Verify the locations of all utilities at the construction site and relocate utilities as required to allow for the installation of the sheet piling.
2. Trench excavate and remove all obstacles and obstructions along the drive lines that would interfere with the installation of the sheet piling.
3. Install the sheet piling as detailed on the plan and section views.
4. Excavate to the bottom of various slabs and caisson caps as shown on the plan and section views.
5. Construct the building as detailed on the Contract Drawings.
6. All sheet piling to remain in place.

NOTES:

1. ALL DIMENSIONS ARE IN C.C.D.
2. 100'-0" BUILDING = +32.46'C.C.D.

- REFERENCES:
1. GEOTECHNICAL REPORT BY GSG CONSULTANTS DATED 7-26-21.
  2. DRAWINGS RECEIVED BY EMAILED ON 11-2-21.

7100 INDUSTRIAL HIGHWAY  
GARY, INDIANA

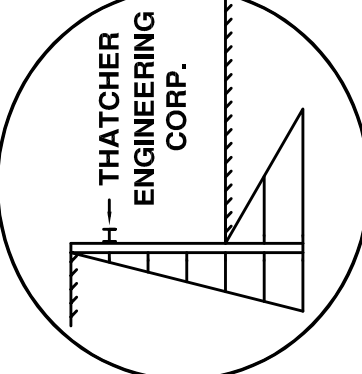

EARTH RETENTION SYSTEM

6040 N. KILPATRICK AVENUE  
CHICAGO, ILLINOIS

CONTRACT NO:  
SCALE: 1/8"=1'  
DATE: 11/8/21  
DRAWN BY: AP  
APPROVED BY:

ERS1